

PROJECT DIRECTORY

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DRAWING LIST

COVER SHEET PROJECT INFORMATION A0.00 EXISTING SITE SURVEY DEMOLITION PLAN
OFF SITE DEMOLITION PLAN A1.0 SITE PLAN OFF SITE AND BRIDGE PLAN A1 0 2 COURTYARD PLAN SITE LIGHTING FLOOR PLAN - LEVEL ' A1.1 FLOOR PLAN - LEVEL 2 A1.3 FLOOR PLAN - LEVEL 3 ROOF PLAN EXTERIOR ELEVATIONS A2.0 EXTERIOR ELEVATIONS EXTERIOR VIEWS A3.0 BUILDING SECTIONS BUILDING SECTIONS BLDG SECTION / INTERIOR VIEWS

S A S M SELF ADHERED SHEET MEMBRANE

S.C. SOLID CORE SCHED SCHEDULI

SCHED SCHEDULE SECT. SECTION S.F.SQUARE FOOT SHT. SHEET SIM. SIMILAR SNT SEALANT SPEC. SPECIFICATION SO SQUARE

SQ. SQUARE S.S. STAINLESS STEEL

STAGG. STAGGERED STD. STANDARD

STRUC STRUCTURAL

T&B TOP AND BOTTOM

TONGUE AND GROOVE THICK

UON UNLESS OTHERWISE NOTED

VCT VINYL COMPOSITION TILE

VER VERIFY V.I.F. VERIFY IN FIELD VERT. VERTICAL

W WEST

SUSP SUSPENDED

STL. STEEL

TR TREAD

Fairchild Broms Design

PO BOX 1528

76 ALBER SAN RAF/ APN:XXX

ADMINISTRATIVE AREAS) 11.29.22 SCHEMATIC DESIGN & SUBMITTAL REVISED

SCALE

SHEET TITLE

2022 CALIFORNIA MECHANICAL CODE 2022 CALIFORNIA PLUMBING CODE 2022 CALIFORNIA ELECTRICAL CODE 2022 CALIFORNIA GREEN BUILDING STANDARDS CODE

Jessica Fairchild Cheryl Lentini

SAN ANSELMO, CA 94960 415,459,8699

NOT FOR CONSTRUCTION

ARCHITECT / ENGINEER STAM

SCHEMATIC DESIGN &

PLANNING SUBMITTAL

Description

3 STORIES BUILDING: 11 405 SE 4,570 SF (ON ROOFS) 1,625 SF (ON GROUND)

FLOOD ZONE AE WITH BFE 11

EXISTING SITE GRADES: 7.5' - 9.5

PROJECT INFO

SITE ADDRESS:

SETBACKS

USE:

STORIES

AREAS:

LEGAL DESCRIPTION:

MAX BLDG HEIGHT:

OCCUPANCY GROUP:

ALLOWABLE LOT COVERAGE: 60%

THE PROJECT INCLUDES THE DEMOLITION OF ALL NON-

HISTORIC BUILDINGS, STRUCTURES, AND CAGING ON THE EXISTING WILDCARE PROPERTY LOCATED AT 76 ALBERT PARK LANE, THE RELOCATION AND RESTORATION OF THE

HISTORIC TERWILLIGER BUILDING, AND THE CONSTRUCTION OF A NEW THREE STORY BUILDING AND CAGING ON THE

THE PROJECT REPLACES EXISTING OUTDATED, UNDERSIZE THE PROJECT REPLACES EXISTING OUTDATED, UNDERSIZED FACILITIES WITH NEW, CODE COMPLIANT ANIMAL HOSPITAL, EDUCATIONAL, AND ANIMAL HOUSING FACILITIES. THE PROJECT ALSO INCLUDES REPLACEMENT OF THE EXISTING PEDESTRIAN BRIDGE OVER SAN RAFAEL CREEK, ALONG WITH CREEK MITIGATION AS REQUIRED ALONG THE SECTION OF CREEK FRONTING THE PROPERTY.

SAN RAFAEL, CA 94901

0.36 ACRES (15.085 SF) - 60%

APN: 013-061-54

FRONT - 15'

REAR - 5' STREET

MULTI-FAMILY RESIDENTIAL DISTRICTS HIGH DENSITY

EDUCATIONAL FACILITY

(HOSPITAL &

WILDLIFE ANIMAL HOSPITAL AND

APPLICABLE CODES

2022 CALIFORNIA BUILDING CODE

2022 CALIFORNIA BUILDING CODE VOLS 1 AND 2

ALONG WITH OTHER APPLICABLE LOCAL, STATE AND

COVER SHEET

20011

11.29.22

1/4" = 1'-0"

GENERAL NOTES

THE INTENT OF THE CONTRACT DOCUMENTS IS TO DEFINE THE NEW CONSTRUCTION AND THE ALTERATION OF EXISTING FACILITIES IN THE SCOPE OF WORK IN ACCORDANCE WITH THE CALIFORNIA CODE OF REGULATIONS (C.C.R.) TITLE 24. THE SPECIFICATIONS ARE A VITAL PART OF THESE CONTRACT DOCUMENTS. THE CONTRACTOR AND

THEIR PERSONNEL SHALL BECOME INTIMATELY FAMILIAR WITH THE SPECIFICATIONS PRIOR TO DIDDING THE PROJECT AND STARTING ANY CONSTRUCTION.

ALL WORK SHOWN IS NEW UNLESS OTHERWISE NOTED OR GRAPHICALLY INDICATED AS EXISTING. DIMENSIONING CONVENTION (UNLESS OTHERWISE NOTED): EXTERIOR WALLS = FACE OF SHEATHING OR CONTRELL BO STEEL; FACE OF CONCRETE MASONRY; FACE OF CONCRETE. INTERIOR PARTITIONS = FACE OF GWB OR CENTER LINE OF STUD AS NOTED ON THE DRAWINGS.

GENERAL CONTRACTOR TO VERIFY ALL EXISTING CONDITIONS PRIOR TO START OF WORK AND ADVISE THE ARCHITECT OF MAY DEVIATIONS SUFFICIENTLY IN ADVANCE TO ALLOW RESOLUTION PRIOR TO AFFECTING RELATED WORK.

DO NOT SCALE THESE DRAWINGS. MATERIAL QUANTITY TAKEOFFS SHALL BE DETERMINED BY THE CONTRACTORS AND SHALL BE BASED ON DRAWING DIMENSIONS. IF A DIMENSION IS MISSING THAT

PRECLUDES THE CONTRACTOR'S ABILITY TO PREPARE AN ACCURATE BIID, THAT DEFICIENCY SHALL BE BROUGHT TO THE ATTENTION OF THE ARCHITECT PRIOR TO BID SUBMISSION. IT IS THE RESPONSIBILITY OF THE GENERAL CONTRACTOR TO SEE TO IT THAT ALL MATERIALS

AND/OR WORK DESCRIPTOR PROGRESS OF THAT THE GENERAL DWITTEN OF THE SE DOCUMENTS BE FURNISHED AND/OR WORK DESCRIPTOR PROGRESS OF THAT LOXALION OF THE MATERIAL OR WORK WITHIN THE DOCUMENTS. WORK OMITTED BY A SUBCONTRACTOR ON HISHER HID HUT SHOWN WITHIN THE'S DOCUMENTS SHALL BE CONSIDERED COVERED BY THE GENERAL CONTRACTOR. ALL CONTRACTORS WHETHER THE GENERAL OR SUBCONTRACTOR SHALL CONSIDER THESE

THESE DOCUMENTS MUST BE BROUGHT TO THE ATTENTION OF THE ARCHITECT

THE CONTRACTORS ARE RESPONSIBLE FOR MAINTAINING TEMPORARY FENCING AND GATES SIGNAGE: SECURITY LIGHTING, OR OTHER SECURITY AND CONTROL MEASURES NECESSARY TO PROVIDE FOR THE SAFETY OF THE STAFF AND MISTORS OF THE ADJACENT TENANT UNTIL THE COMPLETION OF THE WORK UNLESS OTHERWISE DETERMINED BY THE OWNER, CONTRACTOR IS RESPONSIBLE FOR REVIEWING TEMPORARY FENCING WITH THE LOCAL FIRE DEPARTMENT

THE CONTRACTORS ARE RESPONSIBLE TO REPAIR AND/OR REPLACE IN KIND ALL PROPERTY

THE CONTRACTOR SHALL LIMIT HIS/HER ACTIVITY TO THE AREA DESCRIBED WITHIN THE DOCUMENTS SO AS TO LIMIT HIS/HER LIABILITY FOR DAMAGED PROPERTY UNLESS OTHERWISE PERMITTED BY THE OWNER.

CONTRACTOR IS RESPONSIBLE FOR OBTAINING ALL REQUIRED PERMITS PRIOR TO COMMENCEMENT OF CONSTRUCTION.

13. THE CONTRACTOR SHALL ASSUME SOLE RESPONSIBILITY FOR THE SAFETY OF ALL PERSONS ON OR ABOUT THE CONSTRUCTION SITE, IN ACCORDANCE WITH APPLICABLE LAWS AND CODES. 14. ALL MATERIAL AND WORKMANSHIP SHALL CONFORM TO ALL CODES LISTED IN THESE DOCUMENTS,

AS WELL AS ALL APPLICABLE CODES IN EFFECT AT THE TIME OF CONSTRUCTION WHETHER EXPLICITLY LISTED IN THE DOCUMENTS OR NOT. WHEN DETAILS LABELED "TYPICAL (TYP)" OR "SIMILAR (SIM)" ARE GIVEN ON DRAWINGS, THE CONTRACTOR SHALL APPLY THE INTENT OF THE DETAIL TO ALL INSTANCES OF THAT SPECIFIC

CONDITION UON. 16. CONTRACTOR AND SUBCONTRACTORS ARE RESPONSIBLE FOR THE ORDER AND MEANS OF

CONSTRUCTION AND ALL TEMPORARY BRACING AND ERECTION DURING CONSTRUCTION 17. APPROVALS BY BUILDING INSPECTORS AND/OR THE OWNER SHALL NOT CONSTITUTE AUTHORITY

TO DEVIATE FROM THE PLANS AND SPECIFICATIONS COMPOSITE WOOD PRODUCTS: SHALL MEET CARB AIR TOXICS CONTROL MEASURES FOR COMPOSITE WOODS: CALGRIEN TABLE 4565.5

INTERIOR PAINTS AND COATINGS: COMPLY W/ VOC LIMITS IN THE AIR RESOURCES BOARD ARCHITECTURAL COATINGS SUGGESTED CONTROL MEASURE AND CALIFORNIA CODE OF REGULATIONS TITLE 17 FOR AEROSOL PAINTS - CALIGREEN TABLE 4.504.3

 LOW VOC AEROSOL PAINTS: MEET BAAGND VOC LIMITS (REGULATION 8, RULE 49) AND PROUCT WEIGHTED MIR LIMITS FOR ROC. - CAL GREEN 4.504.2.3 21. LOW YOC CAULKS, CONSTRUCTION ADHESIVES AND SEALANTS: MEET SCAOMD RULE 1168 - CAL GREEN TABLES 4.504.1 & 4.504.2 (CAL GREEN 4.504.2.1)

MOISTURE CONTENT OF BUILDING MATERIALS: VERIEY WALL AND FLOOR FRAMING DOLS NOT EXCEED 19% MOISTURE CONTENT PRIOR TO ENCLOSURE, MATERIALS W/ VISIBLE SIGNS OF MOISTURE DAMAGE SHALL NOT BE INSTALLED. MOISTURE CONTENT SHALL BE VERIFIED PER CAL

23. BUILDING IS IN THE WILDLAND-URBAN INTERFACE ZONE AND SHALL COMPLY WITH THE PROVISIONS OF CBC CHAPTER 7A

CONSTRUCTION WASTE

. CONSTRUCTION WAASTE SHALL BE RECYLCLED AND DOCUMENTED PER REQUIREMENTS OF ZERO WASTE MARIN . ALL UNIVERSAL WASTE SHALL BE DISPOSED OF PROPERLY AND DOCUMENTATION / VERIFICATION SHALL BE PROVIDED TO THE OWNER AND BUILDING OFFICAL.

a. Electronic devices: Includes any electronic device that is a hazardous waste (with or without a Cathode Ray Tube (CRT)).

including televisions, computer monitors, cell phones, VCRs, computer CPUs and portable DVD players.

b. Batteries: Most household-type batteries, including rechargeable nickel-cadmium batteries, silver button batteries, mercury batteries, alkaline batteries and other batteries that exhibit a characteristic of a hazardous waste

batteries, alkaline batteries and other batteries that exhibit a characteristic of a hazardous waste

c. Electric lamps: Fluorescent tubes and bulbs, high intensity discharge lamps, sodium wapor lamps and electric lamps that contain
added mercury, as well as any other lamp that exhibits a characteristic of a hazardous waste. (e.g., lead).

d. Mercury-containing equipment: Thermostats, mercury wisthes, mercury hermometers, pressure or vacuum gauges, dilators and
weighted tubing, mercury rubber flooring, mercury gas flow regulators, dental amalgams, counterweights, dampers and mercury
added novelties such as jewelly, ornaments and footwear.

e. CRTs: The glass picture tubes removed from devices such as televisions and computer monitors.

f. CRT glass: A cathode ray tube that has been accidently broken or processed for recycling.

g. Non-empty aerosol cans

DIMENSIONING CONVENTIONS

EXCEPT WHERE DIRECTED TO PLACE ITEMS OF THE WORK AT THE "APPROXIMATE LOCATION SHOWN." DO NOT EACEP WHERE DIRECTED FOR THE WORK AT THE APPROXIMATE LOCATION SHOWN, OU MIN SCALE DRAWINGS FOR DIMENSIONAL INFORMATION, ALL ELEMENTS OF THE DRAWINGS MAY NOT BE DRAWN TO EXACT SCALE. ALL DIMENSIONS REQUIRED ARE SHOWN, OR MAY BE DERIVED FROM THOSE SHOWN, ON THE FLOOR PLANS, DETAIL PLANS, ELEVATIONS, SECTIONS, DETAILS, SCHEDULES, AND SPECIFICATIONS. SEE NOTES ON THIS SHEET AND SYMBOLS ON "ARCHITECTURAL SYMBOLS" DRAWING FOR DIMENSION CONVENTIONS USED ON THIS PRODUCT.

2. ALL GRIDLINES ARE TO CENTER OF STUD UNLESS OTHERWISE NOTED.

3. DIMENSIONS ARE TO FACE OF FINISH UNLESS OTHERWISE NOTED.

EXCEPT WHERE SPECIFICALLY NOTED TO THE CONTRARY, ALL DIMENSIONS SHOWN ON THE ARCHITECTURAL DRAWINGS CONFORM TO THE FOLLOWING CONVENTIONS:

DIMENSIONS UTILIZING THE 'CENTER LINE' SYMBOL ARE MEASURED TO:

STRUCTURAL OR DIMENSIONAL GRID LINES.

CENTER LINE OF CONCRETE OR CONCRETE MASONRY UNIT WALL (EXCLUSIVE OF APPLIED FINISHES HAVING THICKNESS OR FURRING). REFER TO THE ARCHITECTURAL PLANS AND SECTIONS, THE STRUCTURAL DRAWINGS, OR THE PARTITION SCHEDULE TO DETERMINE THE THICKNESS OF

CONCRETE OR CONCRETE MASONRY UNIT WALLS. CONCRETE OF CONCRETE MASONRY UNIT WALLS.
CENTER LINE OF INTERIOR PARTITION ASSEMBLY (EXCLUSIVE OF APPLIED FINISHES HAVING THICKNESS WHICH MAY BE ADDED TO SUCH WALLS) AT PARTITIONS FRAMED WITH WOOD OR METAL

CENTER LINE OF DOOR, WINDOW, OR LOUVER OPENING.

CENTER LINE OF EQUIPMENT OR FURNISHING. CENTER LINE OF OTHER FEATURES AS INDICATED.

B. DIMENSIONS UTILIZING THE 'FACE OF' SYMBOL ARE MEASURED TO:
 FACE OF CONCRETE OR CONCRETE MASONRY UNIT WALL (EXCLUSIVE OF APPLIED FINISHES HAVING THICKNESS OR FURRING WHICH MAY BE ADDED TO SUCH WALLS).
 FACE OF EXTERIOR STUDS (EXCLUSIVE OF APPLIED FINISHES HAVING THICKNESS WHICH MAY BE ADDED TO SUCH WALLS).

 FACE OF INTERIOR PARTITIONS ASSEMBLY (EXCLUSIVE OF APPLIED FINISHES HAVING THICKNESS WHICH MAY BE ADDED TO SUCH WALLS).

WHICH MAY BE ADDED TO SUCH WALLS). UNLESS NOTED AS A "FACE OF FINISH" OR "CLEAR" DIMENSION (SEE NOTES BELOW), DIMENSIONS ARE NOT MEASURED TO THE FACE OF APPLIED FINISH.

INSIDE EDGE OF FINISHED DOOR OPENING, REFER TO "DOOR SCHEDULE" FOR ADDITIONA DIMENSION OR WORK POINT AS INDICATED ON RELATED ARCHITECTURAL DETAIL PLAN. SECTION ELEVATION, CONFIGURATION DETAIL OR CONSTRUCTION DETAIL.

C. WHERE "FACE OF FINISH" OR "CLEAR" DIMENSIONS ARE SPECIFICALLY NOTED. DIMENSION IS MEASURED. FINISH FACES AT THE MOST NARROW OR CONSTRICTED POINTS OF THE SECTION WHERE THI

FINISH FACES AT THE MOST INARKOW OR CONSTRICTED PUBLIS OF THE SECTION WHERE THE DIMENSION IS SHOWN WHEN THE DIMENSION OCCURS ACROSS AN OPEN SPACE: IN THIS CASE, A "FACE OF FINISH" DIMENSION. IS EQUIVALENT TO A "CLEAR" DIMENSION. FINISH FACES AT THE WIDEST OR MOST EXPANSIVE POINTS OF THE SECTION WHERE THE DIMENSION IS SHOWN WHEN THE DIMENSION OCCURS ACROSS AN OBJECT OR GROUP OF OBJECTS.

D. DOORS IN NEW OPENINGS TO BE CENTERED BETWEEN PERPENDICULAR WALLS OR LOCATED WITH A SIDE JAMB 4' FROM A PERPENDICULAR WALL FINISH, UON.

ABBREVIATIONS

AR ANCHOR BOLT A F F ABOVE FINISHED FLOOR A.F.F. ABOVE FINISHED FL AGGR. AGGREGATE ALUM. ALUMINUM ALT. ALTERNATE ANOD. ANODIZED APPROX. APPROXIMATE ARCH. ARCHITECTURAL

BLDG. BUILDING BLK. BLOCK BLK'G BLOCKING BM. BEAM BOT. BOTTOM B LLR BUILT LIP ROOFING

B.W. BOTH WAYS C.I. CONTROL JOINT C.J. CONTROL JOINT
CLG. CEILING
CLKG. CAULKING
CLR. CLEAR
C.M.U. CONCRETE MASONRY UNIT CONC. CONCRETE CONSTR. CONSTRUCTION CONT. CONTINUOUS

DET/DTI DETAIL D.F. DRINKING FOUNTAIN DIAG. DIAGONAL

SYMBOLS

0' - 0"

?

C.T. CERAMIC TILE

EA EACH E.J. EXPANSION JOINT G.C. GENERAL CONTRACTOR E.J. EXPANSION JOINT
E.J.F.S. EXTERIOR INSULATION AND
FINISH SYSTEM
EL. ELEVATION
ELEC. ELECTRICAL
ELEV. ELEVATOR
EMER. EMERGENCY
ENCL ENCLOSINE ENCL. ENCLOSURE EQUIP. EQUIPMENT EXT. Exterior F.A.FIRE ALARM

(F) EXISTING

FURR. FURRING

I EVEL NAME +

SECTION TAG

ELEVATION TAG

DETAIL CALLOUT

SPOT ELEVATION

WINDOW TAG

?

+8'-4"

ELEVATION

D. FLOOR DRAIN F.D.C. FIRE DEPARTMENT FDN/FND FOUNDATION F.E. FIRE EXTINGUISHER F.E.C. FIRE EXTINGUISHER CABINE F.F. FINISH FLOOR FEE FINISH FLOOR FLEVATION F.H.C. FIRE HOSE CABINET

F.H.C. FIRE HOSE CABINET FIN.FINISH FL FLOW LINE FLR. FLOOR FLUOR.FLUORESCENT F.O.B. FACE OF BRICK F.O.C. FACE OF CONCRETE F.S. FULL SIZE FL. FOOT OR FEFT FT. FOOT OR FEET FTG. FOOTING

GL. GLASS
GLB GLUE LAM BEAM
GR.GRADE
GYP. GYPSUM
GYP BD. GYPSUM BOARD
GSM GALVANIZED SHEET METAL HB HOSE BIB H.C. HOLLOW CORE H/C HANDICAPPED HDWD HARDWOOD HDWE. HARDWARE H.M. HOLLOW METAL HR HOUR HT. HEIGHT HVACHEATING VENTILATION

GA GALIGE

GALV GALVANIZED

I.D. INSIDE DIAMETER INSUL. INSULATION INT.INTERIOR JAN. JANITOR JH JOIST HANGER JNT. JOINT JST. JOIST

KIT.KITCHENLAB LAB. LABORATORY LAM. LAMINATE LAV. LAVATORY LT. LIGHT

O.T. QUARRY TILE

MAX MAXIMUM

N NORTH

(N) NEW

NO. NUMBER

MECH MECHANICAL

MFR. MANUFACTURER
MIN. MINIMUM
MISC. MISCELLANEOUS
M.O. MASONRY OPENING
MTL. METAL
MUL. MULLION

N.I.C. NOT IN CONTRACT

NOM. NOMINAL N.T.S. NOT TO SCALE

O.D. OUTSIDE DIAMETER

P.L. PROPERTY LINE
P.LAM. PLASTIC LAMINA

PLAS. PLASTER

PR PAIR

PLYWD. PLYWOOD

O.C. ON CENTER

OPG. OPENING OPP. OPPOSITE

R. RISER
(R) REMODELED
R.D. ROOF DRAIN
RE: REFER TO
REFR. REFRIGERATOR
REINF. REINFORCED

W.C. WATER CLOSET WD. WOOD W/O WITHOUT REQ'D. REQUIRED

RM ROOM R.O. ROUGH OPENING RWL RAINWATER LEADER

LOCATION MAP



FINISH TAG

.0 CEILING HEIGHT

9

FEDERAL LAWS AND REGULATIONS

(?) DOOR TAG

PROJECT CODE SUMMARY

Allowable Floor Area: Sprinklered / Multi Story Type VB Sprinklered

Allowable Bldg Ht / Stories

B Occupancy 27,000 SF

Issue	Item		Code Reference	Development Standards – Project	Data:	
1. Occupancy Groups:	Room(s)	Occupancy	Sec. 302 - 314 Sec. 509	Parcel #: 013-061-54 Lot Size: 15.085 SF (0.56 Agres)		
	Terwilliger Center Historic Bidg Multi-purpose Room	B – Small Assembly classified as B Occupancy	302.1.2.1	Description / Standard	Lxistine	Proposed
	Courtyard	80 MEU 80		Project Site Area	15,085 SF	15,085 SF
	Ampassador Caging	В		Building Area	4,505 SF	11,405 SF
	20.			Hospital Caging Area	3,773 SF (on Ground)	4,570 SF (on Bldg Boots)
	Hospita First Floor			Ambassador Caging Area	2,189 S- (on Ground)	1,525 SF (on Ground)
	Hospital Support	B B		Courtyard Areas	1,288 SF	1,580 SF - 1,237 SF (DECK)
	Administrative Space	B				20
	Caging	5		Lot Coverage (Max 60%)	65% (9,740 SF)	60% (9,051 SF)
	Second Floor			Front Setback (151)	*1,574 SF Caging Area in Setback	
	Hosp la Cacing	B B		Side Setback (51)	*805 SF Caging (669 SF) & Bidg (136 SF) Area in Setbacks	5.
				Rear Setback (5' – Street)	*122 S- Caging Area in Setback	5'
	2rt Floor / Roof Caging	В		Total Setback Encroachment	7,601 SF	0.5F
2. Occupancy Separations	N/A		Table 508.4	Creek Setback (251)	12,078 SF Caging Area in Setback	*758 SF Caging (583 SF) & Blog (175 SF) Area in Setback (3 dg Area is Historic Bldg)
3. Special Requirements Based of	in - Wild Animal Quarantine Facilitie	5	Sec. 1237	Reduction in Area in Creek Setba	ck: 68%	· · · · · · · · · · · · · · · · · · ·
Occupancy	Veterinary Facilities		Sec. 1251			
	Medical Gas Systems		Sec 427	Building Height Limit (36') (Measured from Grade 9.0')	30' - /"	24" = 6" Top of Reef 26" = 6" Top of Parapet 40" = 6" Top of Stair Penthouse
				FAR (Max 1.0 - 15,085 SF)	4,505 SF (0.30)	11,405 SF (0.76)
Actual Floor Area:				Parking	None	None
	Building 11,405 SF	Hospital Caging (To	otal): 4,570 SF	Flood Zone (RFF 111)	0' -11.75'	12"
Total Building Area: 11,405 SF	1# Floor: 6.776 SF + 613* SF = 7.38			Fin Fir Reg 12" or Floodproofed		8
	2 st Floor: 3,212 SF 3 st Floor/ Roof; 804 SF *Covered Cage Area Included in Bio	1,693 SF 2,264 SF Ig Area		*Indicates non compliant constru	tion	
	Open Courlyards: 278 SF + 1,302 SF = 1,580 SF	Ambassador Cagin	g: (Total): 1,625 SF			
The state of the s	RECEIVED AND THE PROPERTY OF T					

Sec. 506, 507 Table 508.2

Tables 504.3, 504.4

Type VB			Chapter 6
Separation Distance	Rating	Opening Protection	
5' <x<10'< td=""><td>1 Hr</td><td>Unprotected,</td><td>Table 601</td></x<10'<>	1 Hr	Unprotected,	Table 601
10' <x<20'< td=""><td>0 Hr</td><td>Sprinklered</td><td>Table 705.5</td></x<20'<>	0 Hr	Sprinklered	Table 705.5
5' <x<10'< td=""><td></td><td>25%</td><td>Table 705.8</td></x<10'<>		25%	Table 705.8
10' <x<16' 15'<x<20'< td=""><td></td><td>45% 75%</td><td></td></x<20'<></x<16' 		45% 75%	
			Sec. 705.2
Element		Haurs	Table 601
		Type VB	
Primary Structura	l freme	0	Table 601
Bearing wals - exterior		0	Table 601
Bearing wals - in	terior	0	Table 601
Noncearing walls and partitions—exterior Noncearing walls and partitions—interior		U	Table 705.5
		0	Table 601
Floor construction members	& associated secondary	0	Table 601
Roof construction	& associated secondary	0	Table 601
	Separation Distance 5 < < 10" 10" < < 20" 5 < < < 10" 10" < < 20" 5 < < < 0" 10" < < 20" Element Primary Structura Bearing walls — et Boaring walls Noncearing walls Noncearing walls Roof construction rembers Roof construction	Separation Distance 5 < x < 10° 10° x < 20° 1 Hr 5 < x < 10° 10° x < 10° 10° x < 10° 10° x < 10° 10° x < 20° Element Primary Structural frame Bearing walls – exterior Boaring walls – intorior Noncearing walls and partitions— exterior Noncearing walls and partitions— exterior Ploor construction & associated secondary members Roof construction & associated secondary	Separation Distance Pating Opening Protection

No increases for street frontage

PROJECT DATA

Development Standards - Project Data:

Description / Standard	Existing	Proposed
Project Site Area	15,085 SF	15,085 SF
Building Area	4,505 \$1	11,405 SF
Hospital Caging Area	3,773 SF (on Ground)	4,570 SF (on Bldg Boots)
Ambassador Caging Area	2,189 S+ (on Ground)	1,525 SF (on Ground)
Courtyard Areas	1,288 SF	1,580 SF - 1,237 SF (DECK)
Lot Coverage (Max 60%)	65% (9,740 SF)	60% (9,051 SF)
Front Setback (15")	*1,574 SF Caging Area in Setback	19'
Side Setback (5")	⁴ 805 SF Caging (669 SF) & Bldg (136 SF) Area in Setbacks	5'
Rear Setback (5' – Street)	*122 S- Caging Area in Setback	5'
Total Setback Encroachment	7,601 SF	0.5F
Creek Setback (251)	12,028 SF Caging Area in Setback	*758 SF Caging (583 SF) & Blog (175 SF) Area in Setback (3 dg Area is Historic Bldg)
Reduction in Area in Creek Setb	ack: 68%	
Building Height Limit (36')	30' - 2"	34' - 6" Top of Roof
(Measured from Grade 9.0")		26′ = 6″ Top of Parapet 40′ = 6″ Top of Stair Penthouse
FAR (Max 1.0 - 15,085 SF)	4,505 SF (0.30)	11,405 SF (0.76)
Parking	None	None
Flood Zone (BFF 111)	$0^{\circ} - 11.75^{\circ}$	12"

PLUMBING FIXTURE COUNT CALCULATIONS

Toilet Fixtures

Occupant Loads A Occupancy | 45 (23 M / 23 F) B Occupancy | 29 (15 M / 15 F)

Required Plumbing Fixtures

A-3 OCCUPANCY Water Closets 1 M (1:100) 1 F (1:25) Urinals 1 M (1:100) B, S OCCUPANCY 1 M (1:50) 1 F (1:15) 4 M (1:100) 1 V (1:75) 1 F (1:50)



Fairchild **Broms** Design

Architects: Jessica Fairchild Cheryl Lentini

PO BOX 1528 SAN ANSELMO, CA 94960 415.459.8699

NOT FOR CONSTRUCTION

ARCHITECT / ENGINEER STAMP

SCHEMATIC DESIGN & PLANNING SUBMITTAL


Date Description No.

11.29.22 SCHEMATIC DESIGN &
PLANNING
SUBMITTAL REVISED

20011 DATE 11.29.22 SCALE

SHEET TITLE

PROJECT INFORMATION

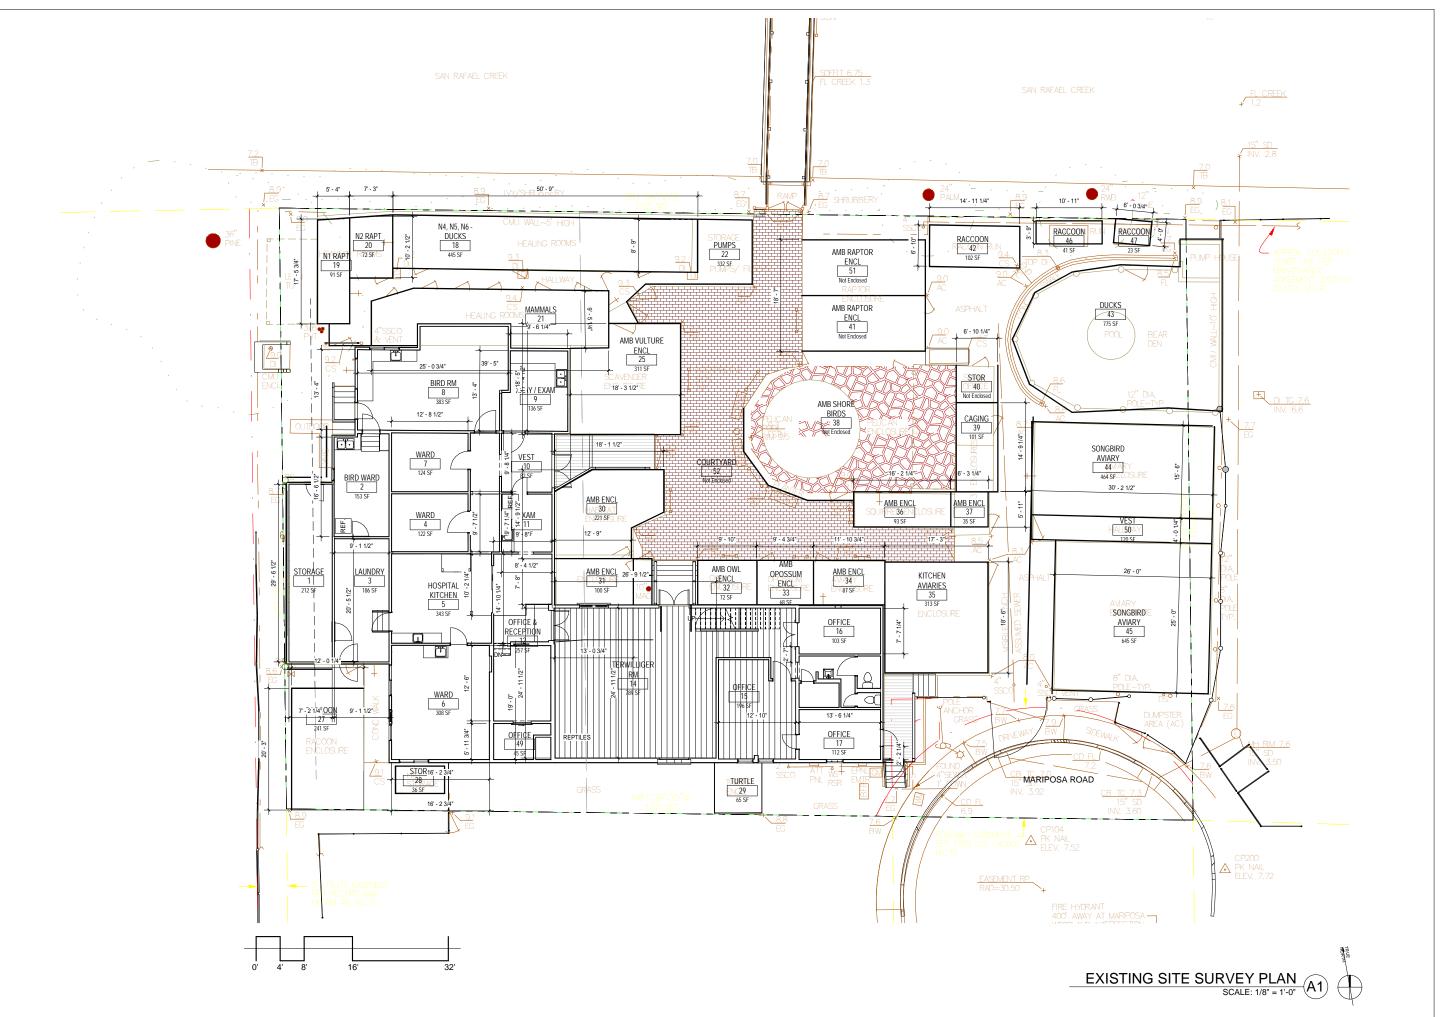



Design
Architects:
Jessica Fairchild

Cheryl Lentini

PO BOX 1528 SAN ANSELMO, CA 94960 415.459.8699 NOT FOR

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PLANNING SUBMITTAL
ISSUE/REVISION

PROJECT NO. 2001 I


DATE 06.20.2 I

SCALE 1/8" = 1'-0"

SHEET TITLE

EXISTING SITE SURVEY

A0.00

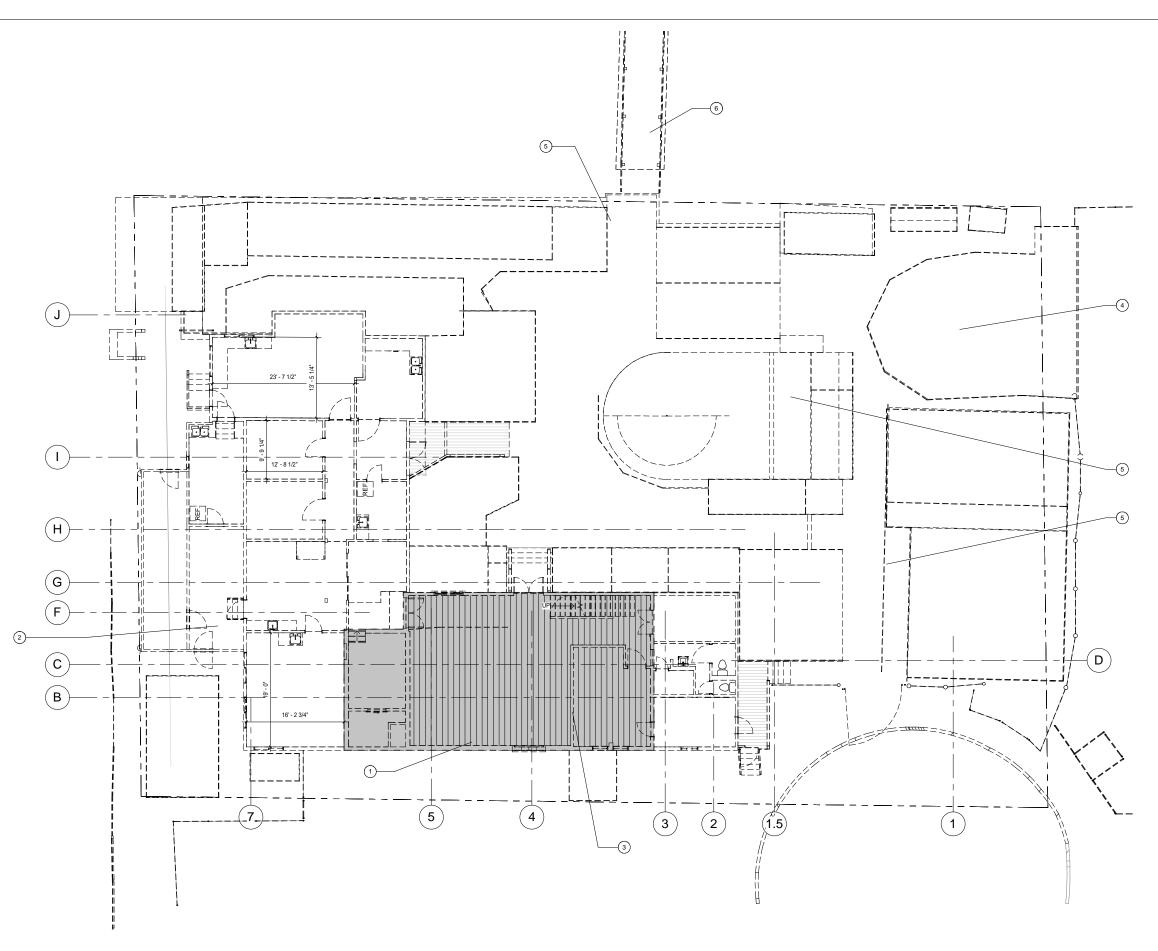

DEMOLITION PLAN - LEVEL 1 &

SCALE: 1/8" = 1'-0" (A1)



KEY NOTES

- 1 EXISTING HISTORIC STRUCTURE TO BE PRESERVED AND RELOCATED (SHOWN SHADED): EXTERIOR WALLS ASSEMBLIES, WINDOWS, TRIMS, DOORS, FLOOR AND ROOF FRAMING, FLOORING, AND ROOFING TO REMAIN AND BE PROTECTED DURING CONSTRUCTION.

 2 REMOVE ALL (E) BUILDINGS & STRUCTURES, INCLUDING CAGING, SHED STRUCTURES, & MISCELLANEOUS FENCING

 3 REMOVE (E) CASEWORK, GWB / FURRING, INTERIOR FINISHES, STAIR CONSTRUCTION, DOORS, PLUMBING FIXTURES, ELECTRICAL SYSTEMS, MEZZANINE, INTERIOR WALLS UON, AND HYAC SYSTEMS.

- 4 REMOVE ALL EQUIPMENT, PLUMBING, & POOLS
 5 REMOVE ALL CONCRETE, ASPHALT, & UNIT
 PAVING
- 6 REMOVE (E) PEDESTRIAN BRIDGE



Fairchild Broms

Design Jessica Fairchild

Cheryl Lentini

415.459.8699

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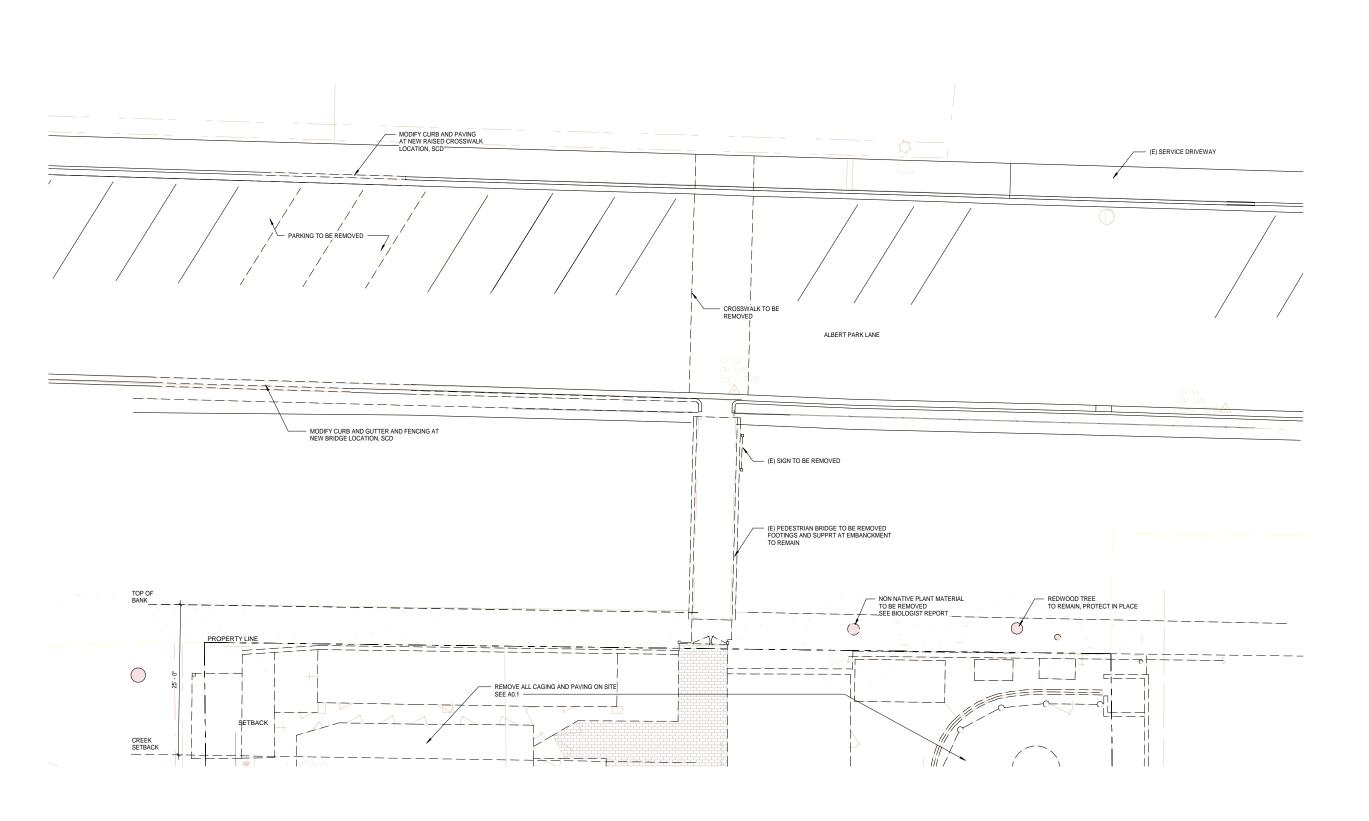
SCHEMATIC DESIGN & PLANNING SUBMITTAL

Date Description N
11.29.22 SCHEMATIC DESIGN &
PLANNING
SUBMITTAL REVISED

PROJECT NO.	20011
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SCALE	1/8" = 1'-0"

SHEET TITLE

DEMOLITION PLAN





Design

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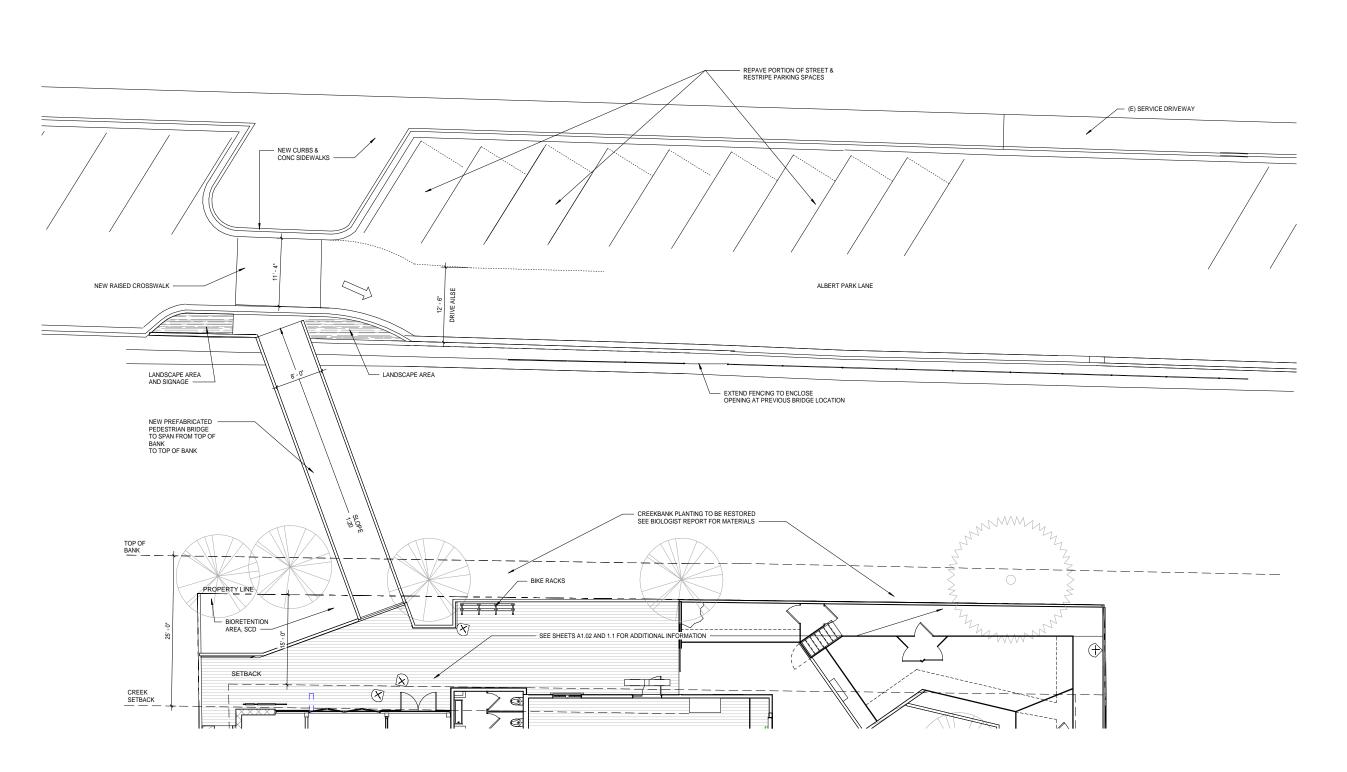
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20011 11.29.22 SCALE 1/8" = 1'-0" SHEET TITLE

OFF SITE DEMOLITION PLAN

OFFSITE DEMOLITION PLAN
SCALE: 1/8" = 1'-0"
A1







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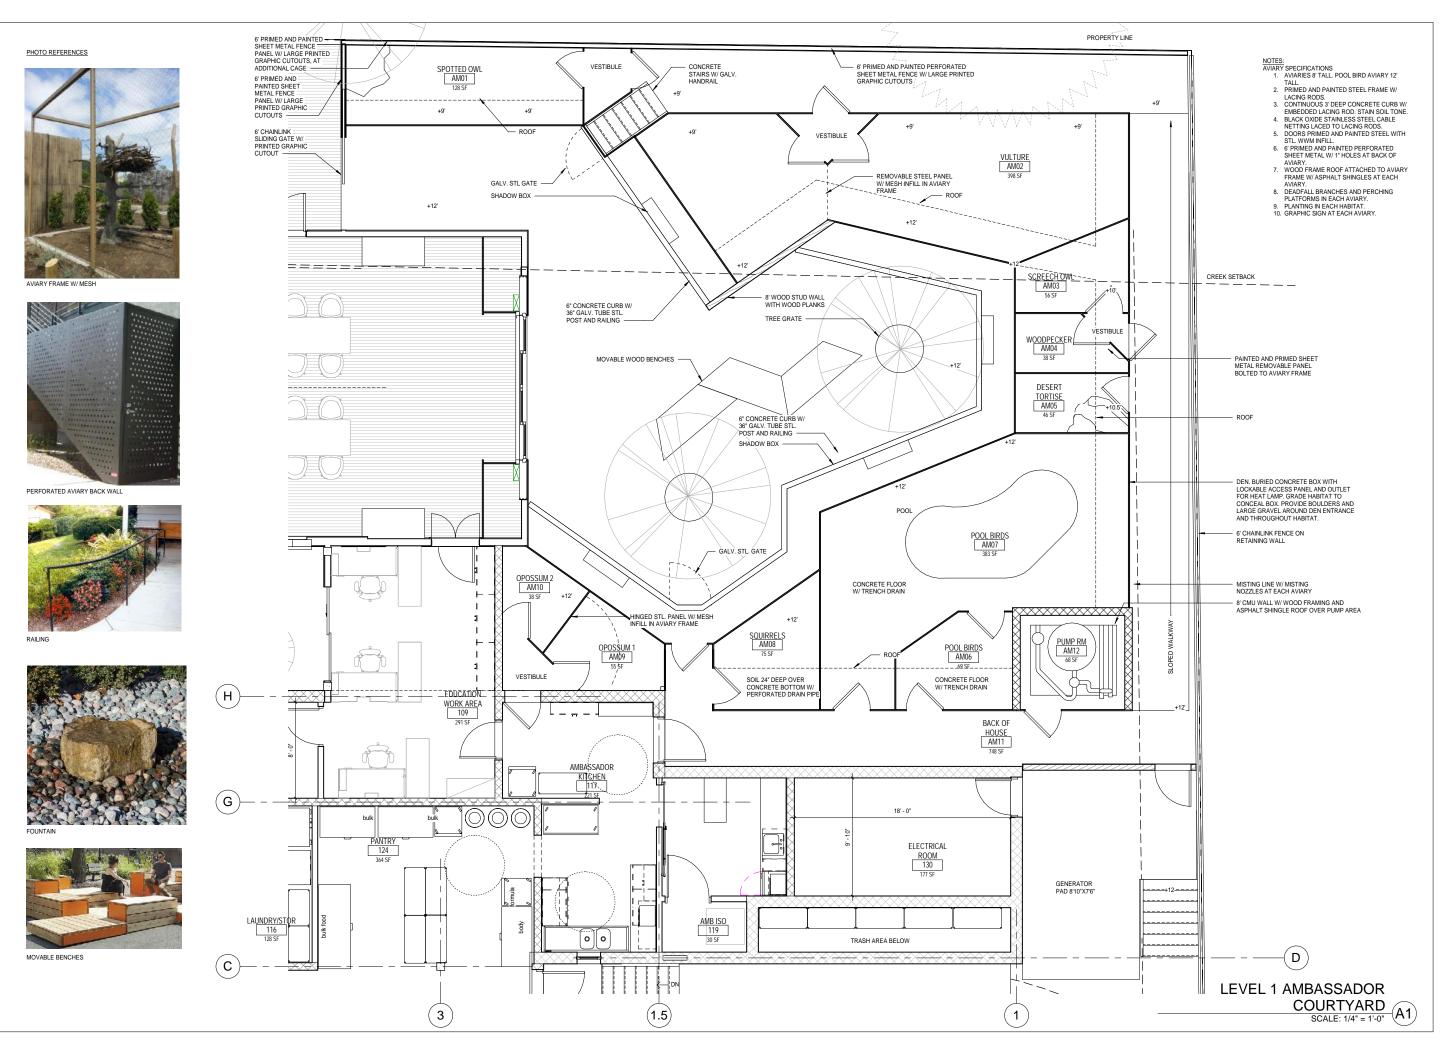
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SCALE

1/8" = 1'-0"

OFF SITE AND BRIDGE PLAN

A1.0.1





ildcare

76 ALBERT PARK LANE SAN RAFAEL, CA 94901 APN:XXX

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Architects: Jessica Fairchild Cheryl Lentini

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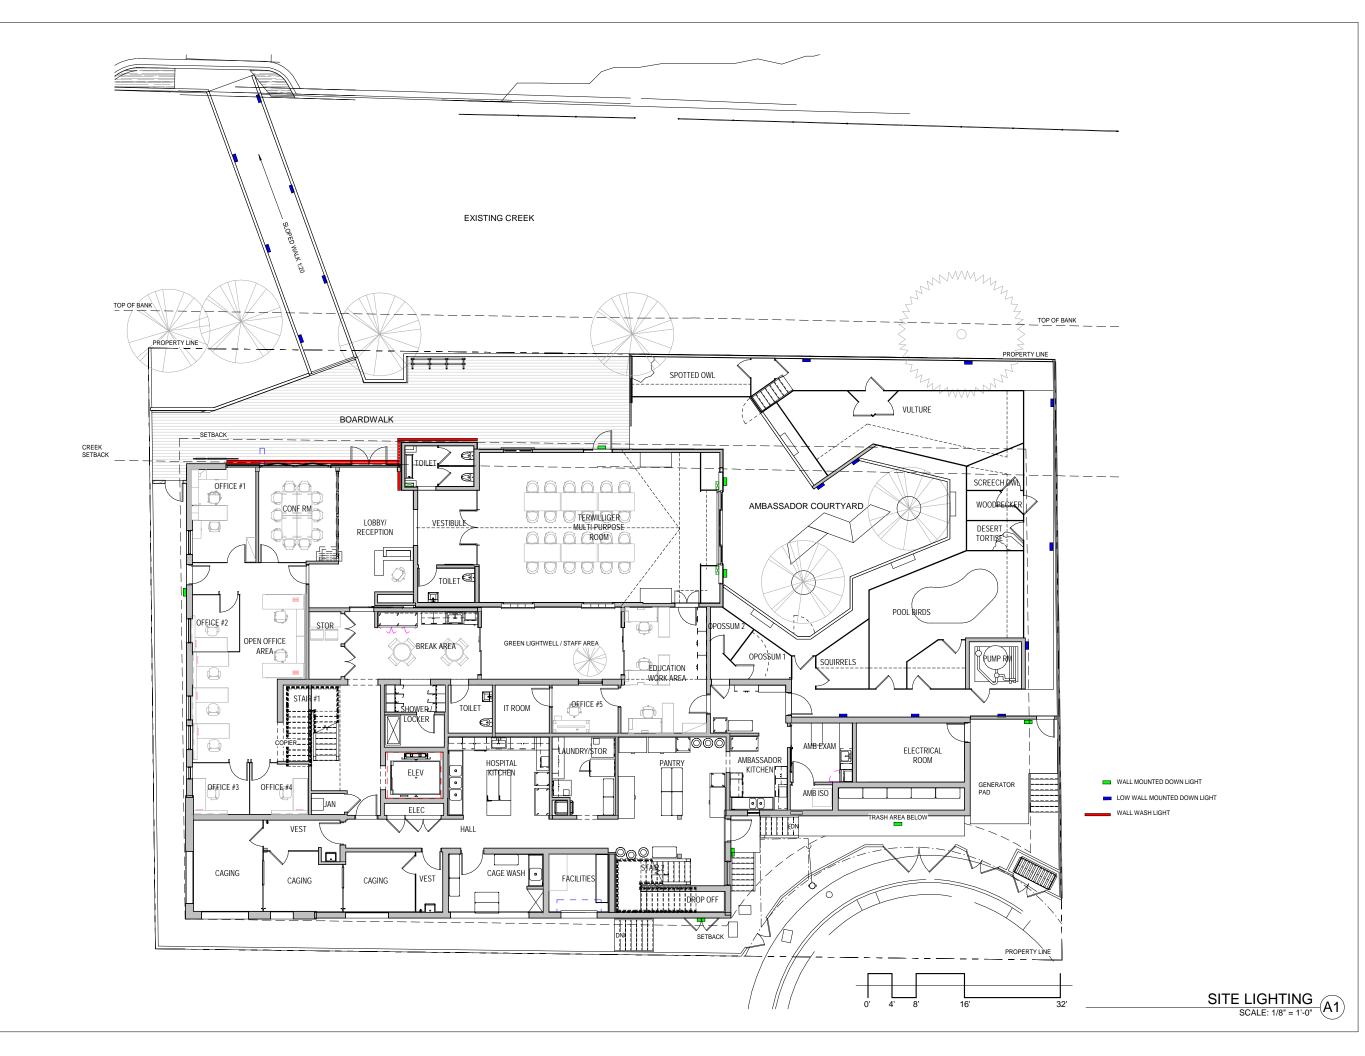
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SCALE 1/4" = 1'-0"

SHEET TITLE

COURTYARD PLAN

A1.0.2





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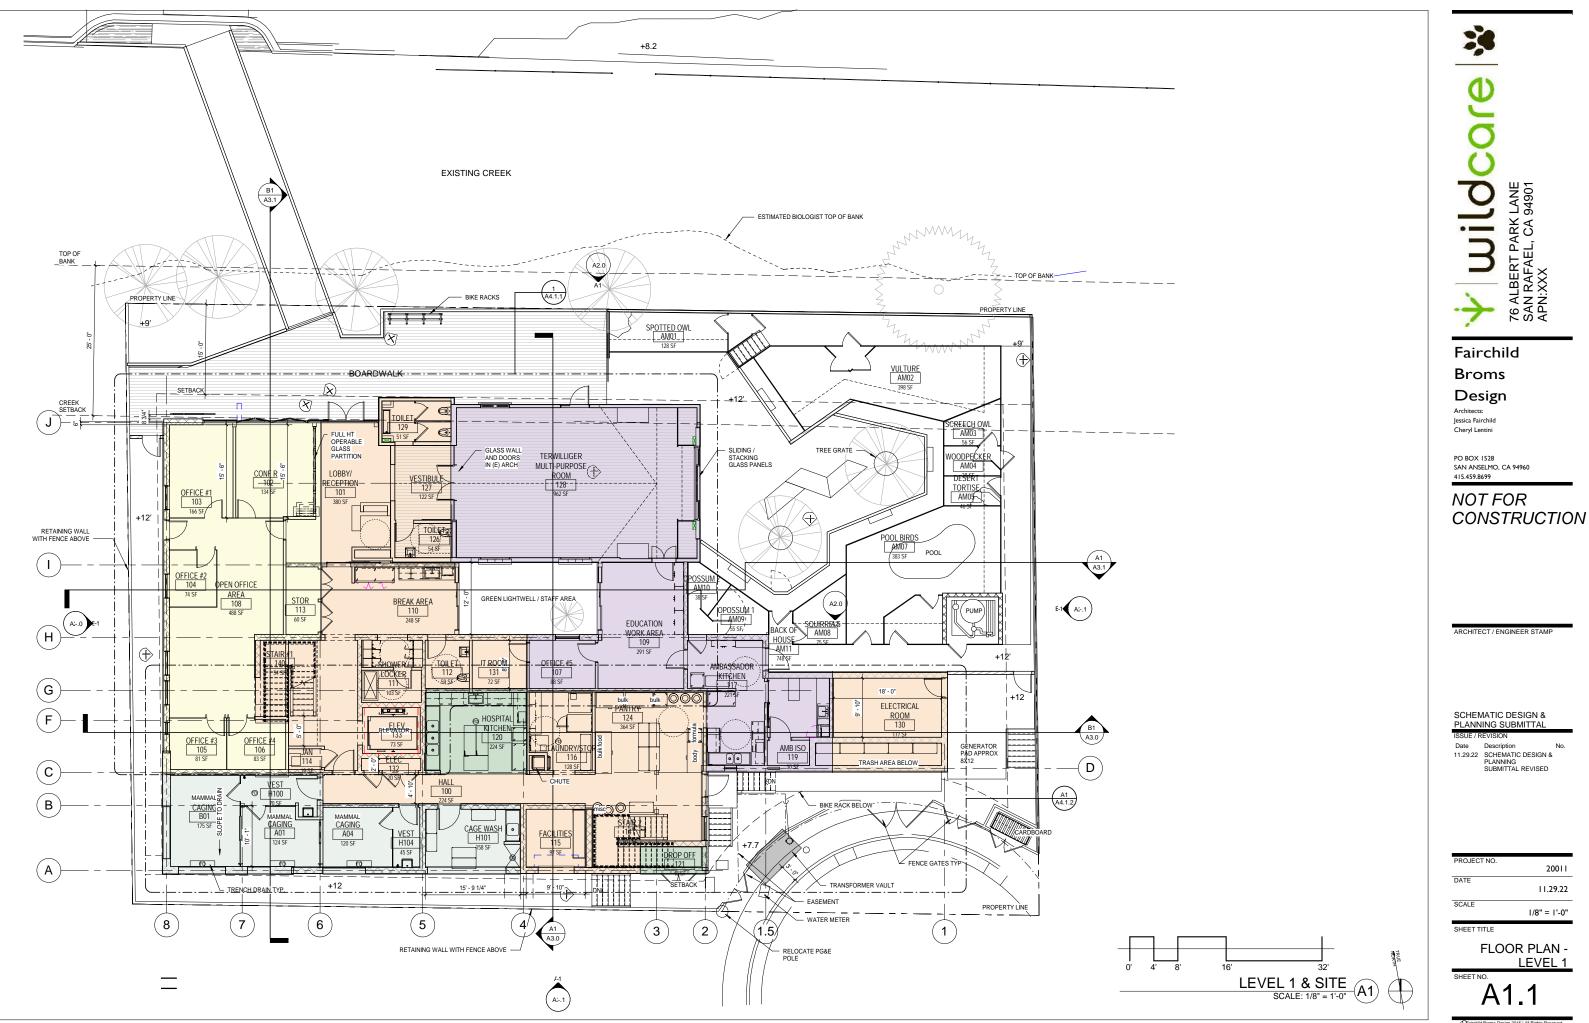
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PROJECT NO.	20011
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SHEET TITLE

SITE LIGHTING

A1.0.3





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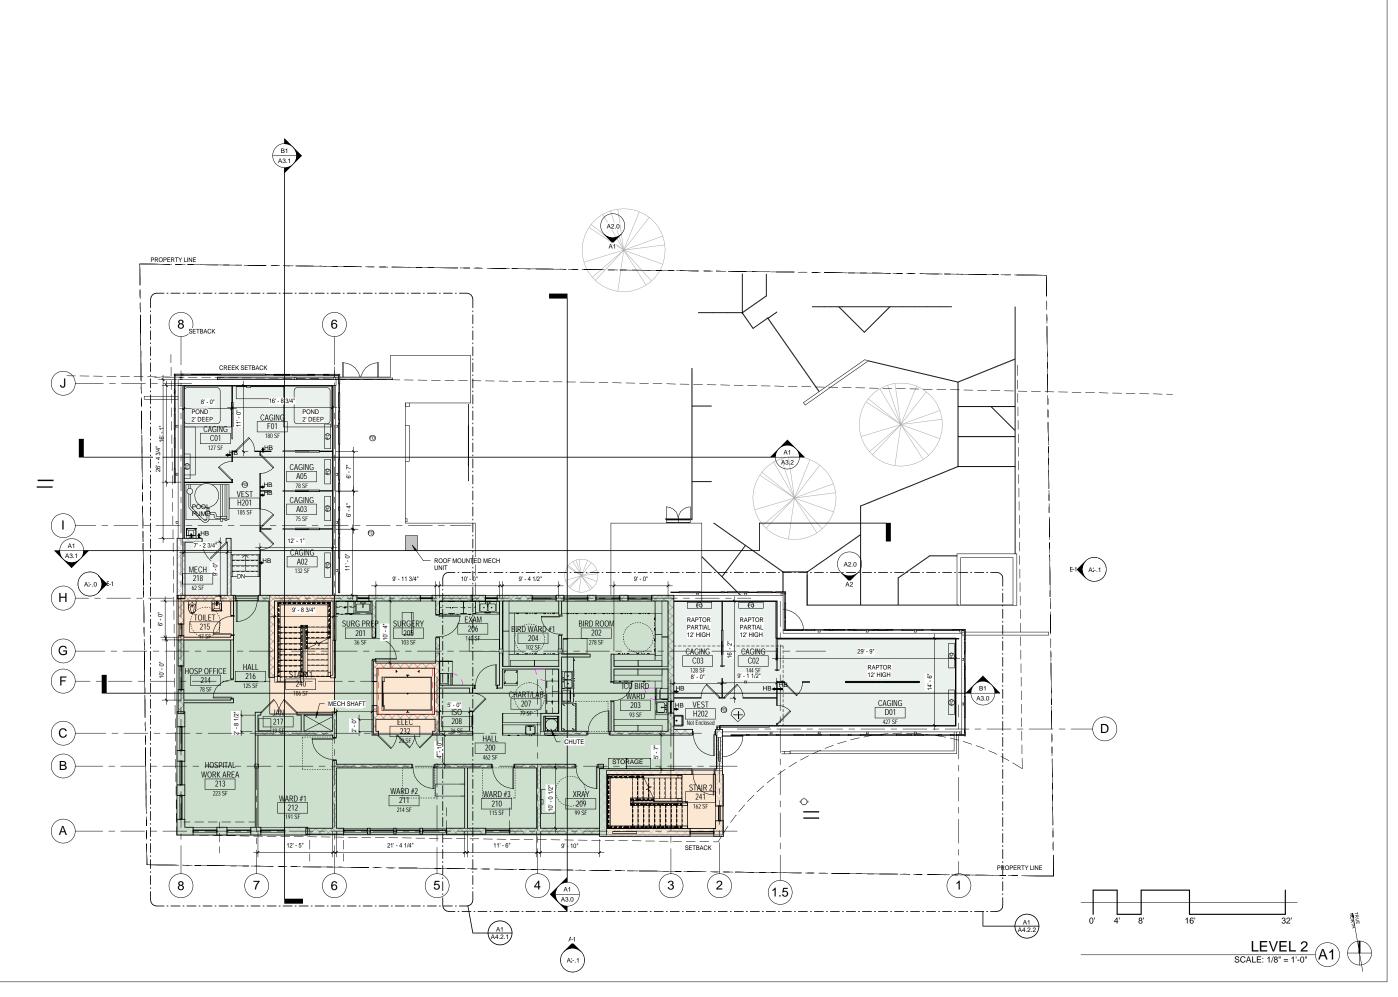
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FLOOR PLAN -LEVEL 1





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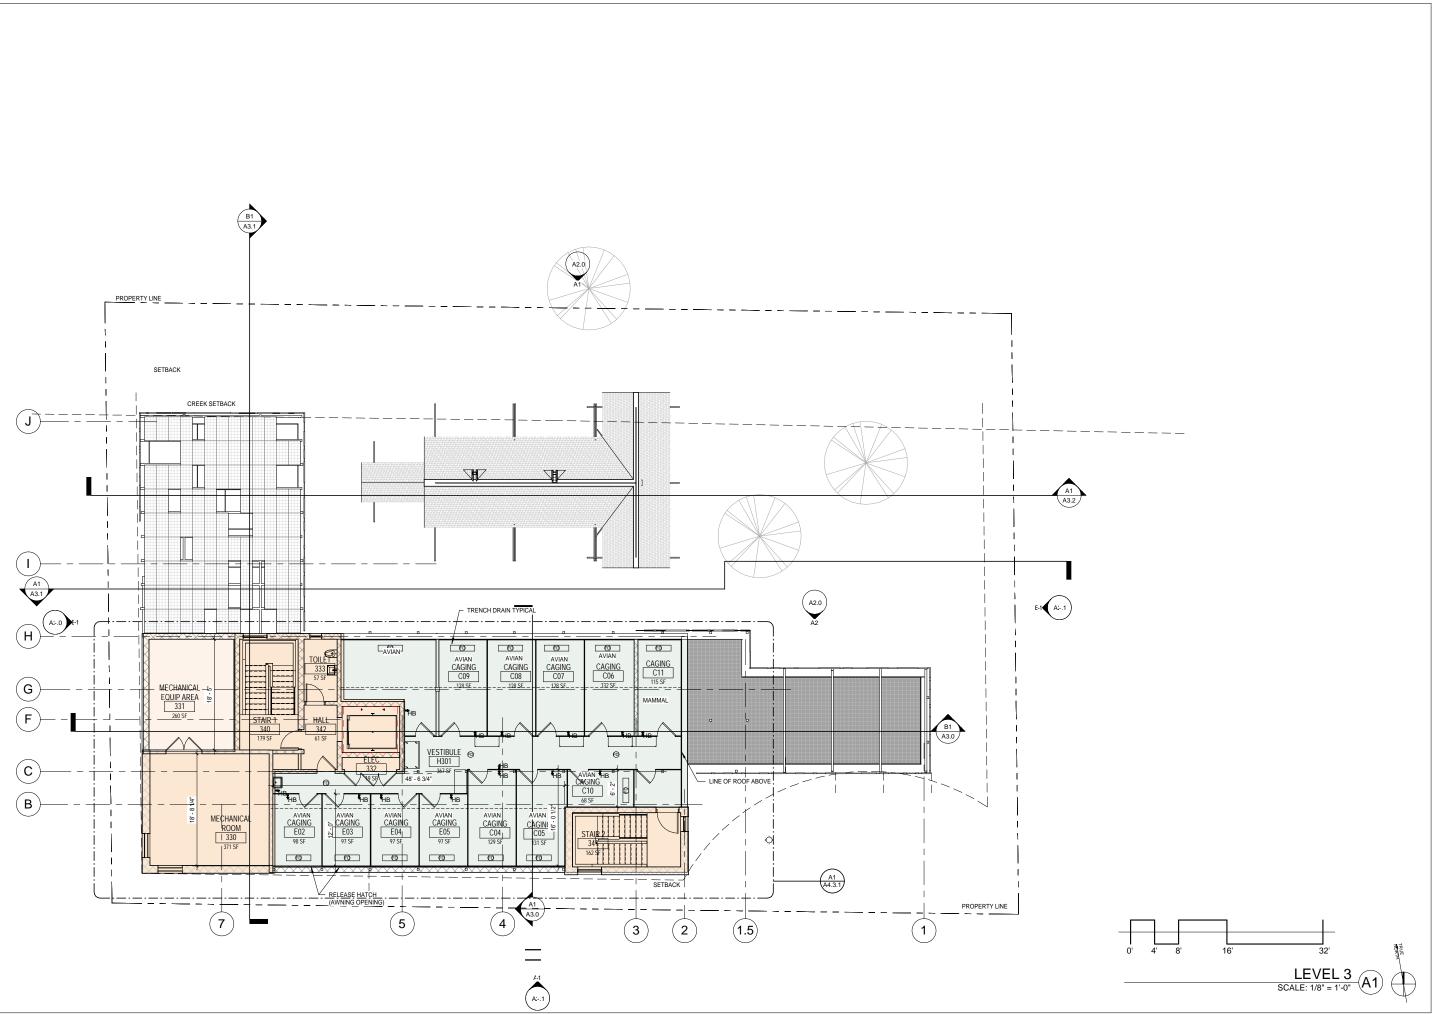
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OUEET TITLE	

FLOOR PLAN -LEVEL 2





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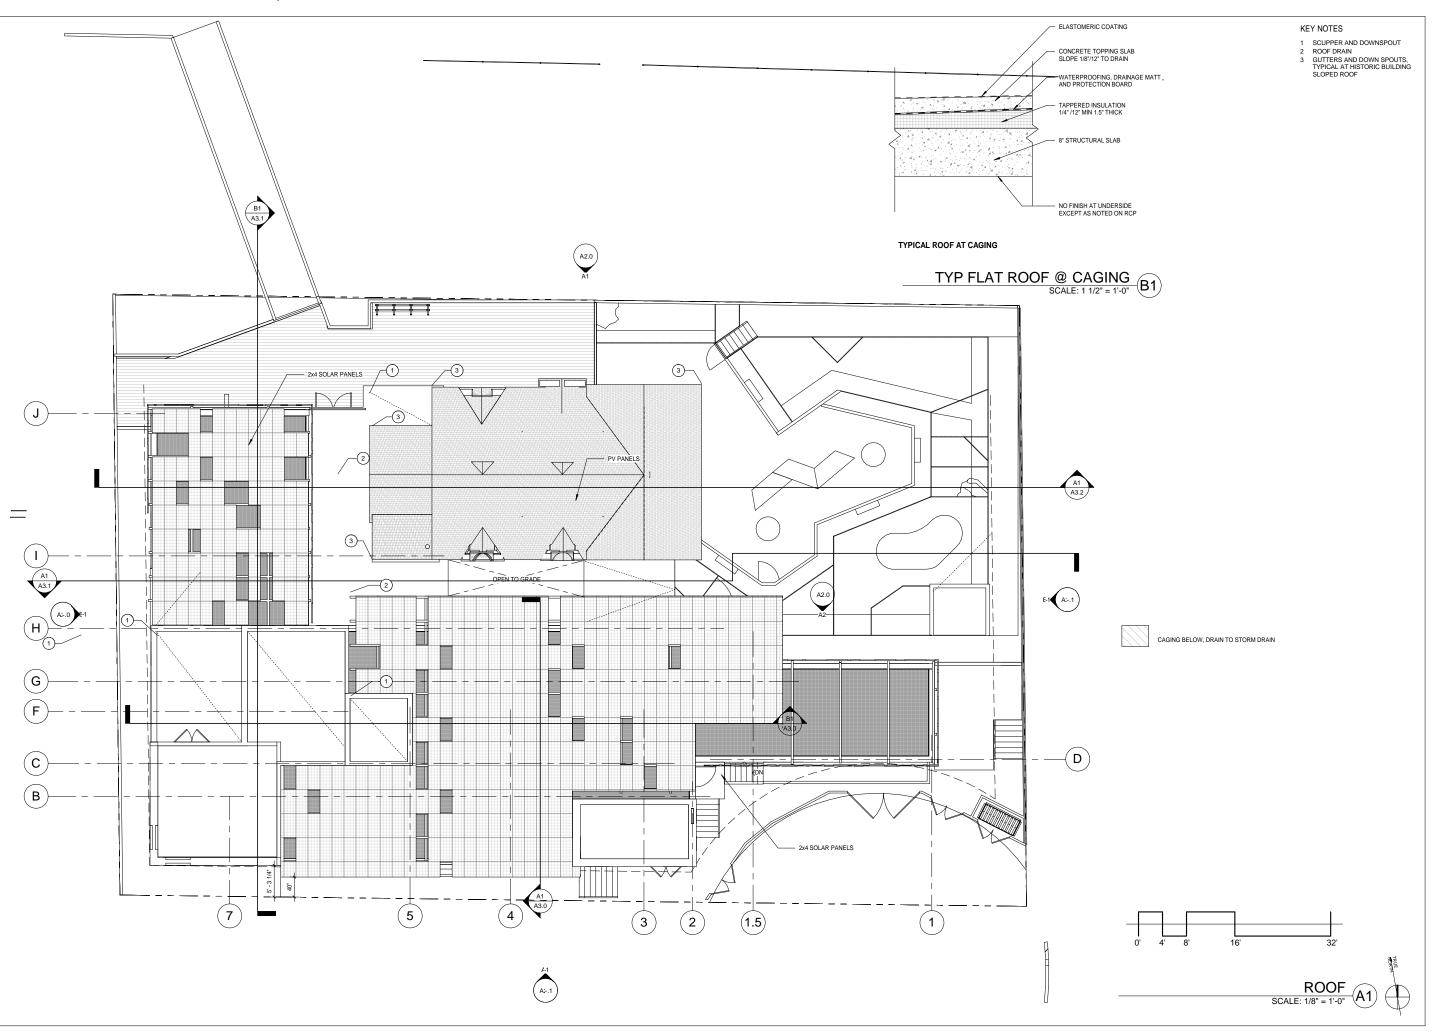
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	SCALE	1/8" = 1'-0"
'	SHEET TITLE	

FLOOR PLAN -LEVEL 3





Architects:
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Cheryl Lentini

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ROOF PLAN

Δ1 <u>Λ</u>





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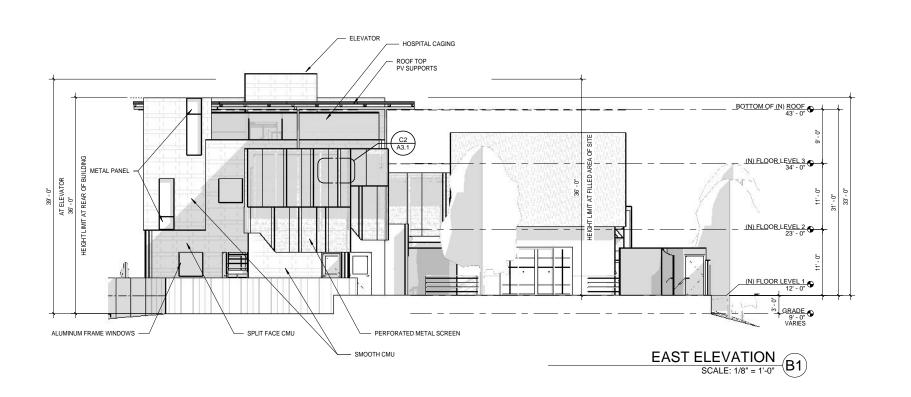
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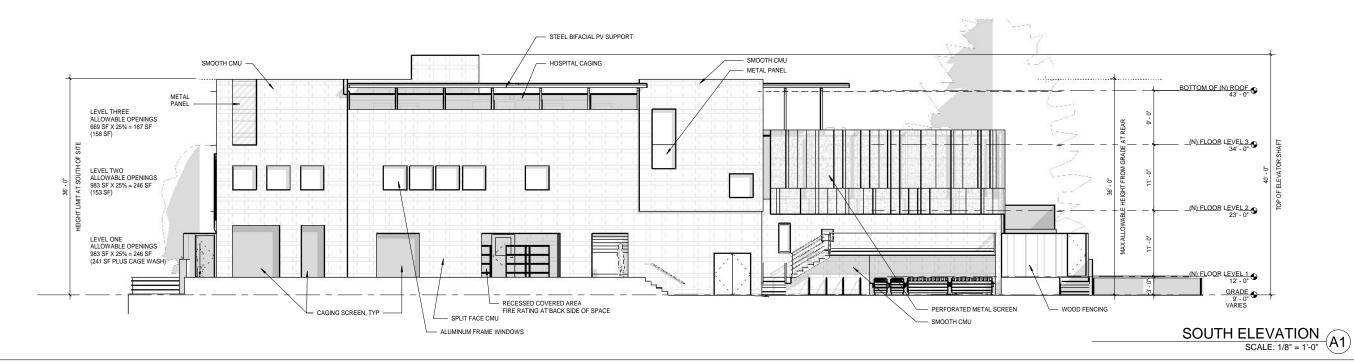
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EXTERIOR ELEVATIONS







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SHEET TITL

EXTERIOR ELEVATIONS

^ A2 1









ALBERT PARK LOOKING WEST SCALE: B1

FROM BRIDGE C1



Fairchild **Broms**

Design

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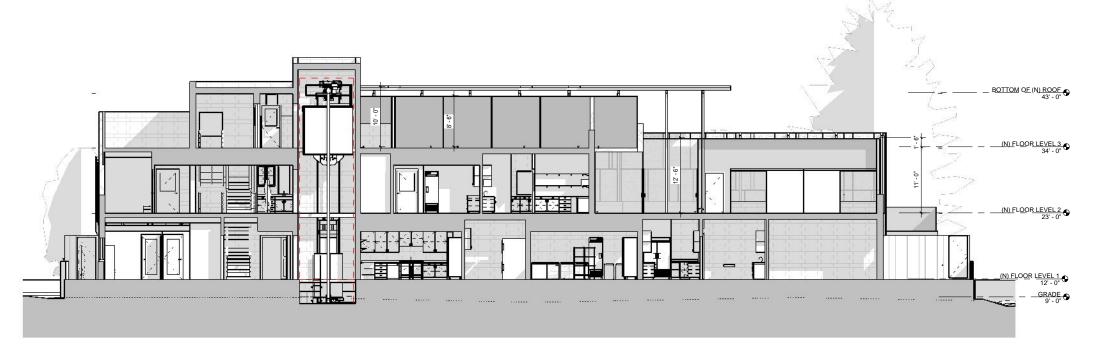
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SHEET TITLE

EXTERIOR VIEWS

ALBERT PARK LOOKING EAST SCALE: (A1)



SECTION LOOKING NORTH
SCALE: 1/8" = 1'-0"
B1



SECTION LOOKING WEST
SCALE: 1/8" = 1'-0"

A1



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Design
Architects:
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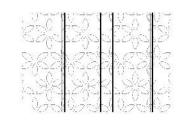
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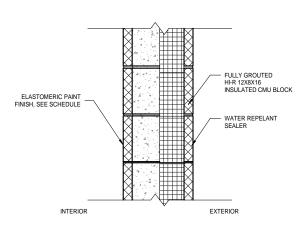
PROJECT NO.	20011
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SCALE	1/8" = 1'-0'
SHEET TITLE	

BUILDING SECTIONS


A3.0



TYPICAL PERFORATED SCREEN PATTERN - OR SIM SCALE: 1/2" = 1'-0" C2




TYPICAL WALL SECTION AT NEW CONSTRUCTION

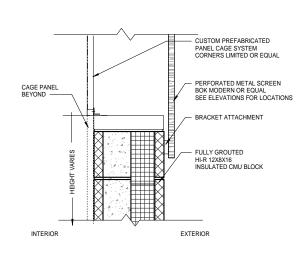


TYPICAL WALL SECTION AT ROOFTOP CAGING WITH SCREEN



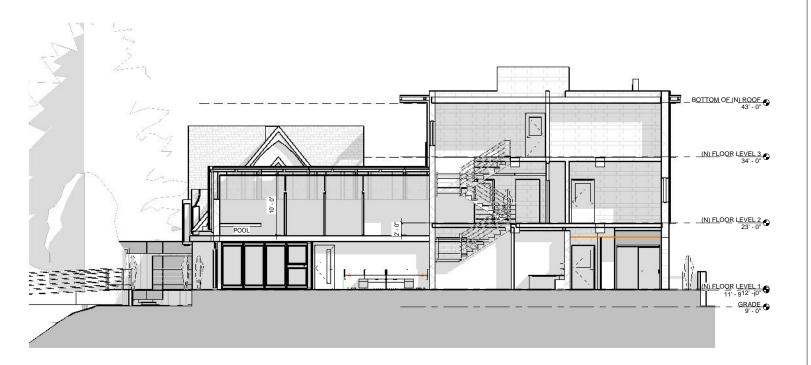

SECTION LOOKING EAST
SCALE: 1/8" = 1'-0"
B1

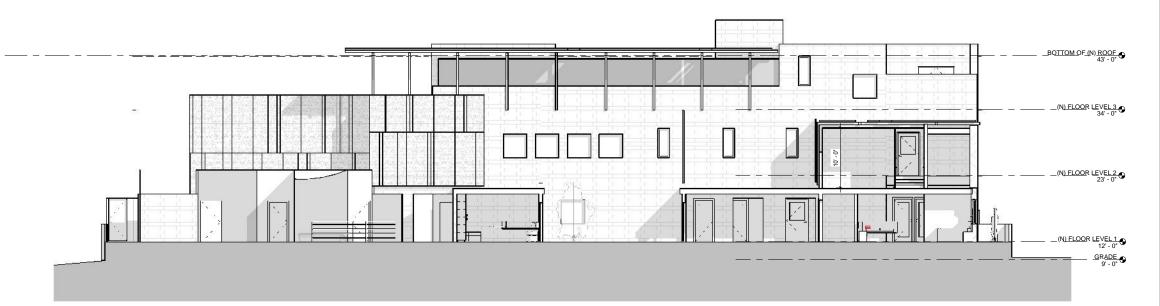

SECTION LOOKING SOUTH SCALE: 1/8" = 1'-0" (A1)



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Design Architects:

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11.29.22

SCALE

As indicated

SHEET TITLE

BUILDING SECTIONS

A3.1





(E) 4X
WOOD STUDS AT 3" OC

(E) DIAGONAL WOOD
PANELING
OR CEDAR SIDING
OR CEDAR SIDING
OR CEDAR SIDING
PAINTED

1" RIGID INSULATION

WATERPROOF MEMBRANE

INTERIOR

EXTERIOR

TYPICAL WALL SECTION AT HISTORIC BLDG

TYP HISTORIC WALL

ASSEMBLY

SCALE: 1 1/2" = 1'-0"

A2



LOGITUDNAL SECTION LOOKING NORTH SCALE: 1/8" = 1'-0" (A1) | wildcore |

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SCALE As indicated

SHEET TITLE

BLDG SECTION / INTERIOR VIEWS

A3.2